


ALL DIMENSIONS SHOWN ARE IN METRES AND/OR MILLIMETRES UNLESS OTHERWISE NOTED.

NOTES:

- REFER TO ELECTRIFICATION STANDARDS AND SPECIFICATIONS FOR GROUNDING AND BONDING, EMI/EMF WITHSTAND REQUIREMENTS, CABLING REQUIREMENTS

NOTE: THIS DRAWING IS PROVIDED FOR INSTRUCTIONAL DESIGN PURPOSES ONLY BASED ON METROLINX GO TRANSIT DESIGN GUIDELINES AND REQUIREMENTS. THE CONSULTANT SHALL VERIFY FOR LOCAL CODE COMPLIANCE, EXISTING SITE CONDITIONS AND INTER DISCIPLINARY DRAWING COORDINATION. ALL DIMENSIONS AND SPECIFICATIONS SHOULD BE VERIFIED BY CONSULTANT AND/OR CONTRACTOR BEFORE ACTUAL CONSTRUCTION BEGINS.

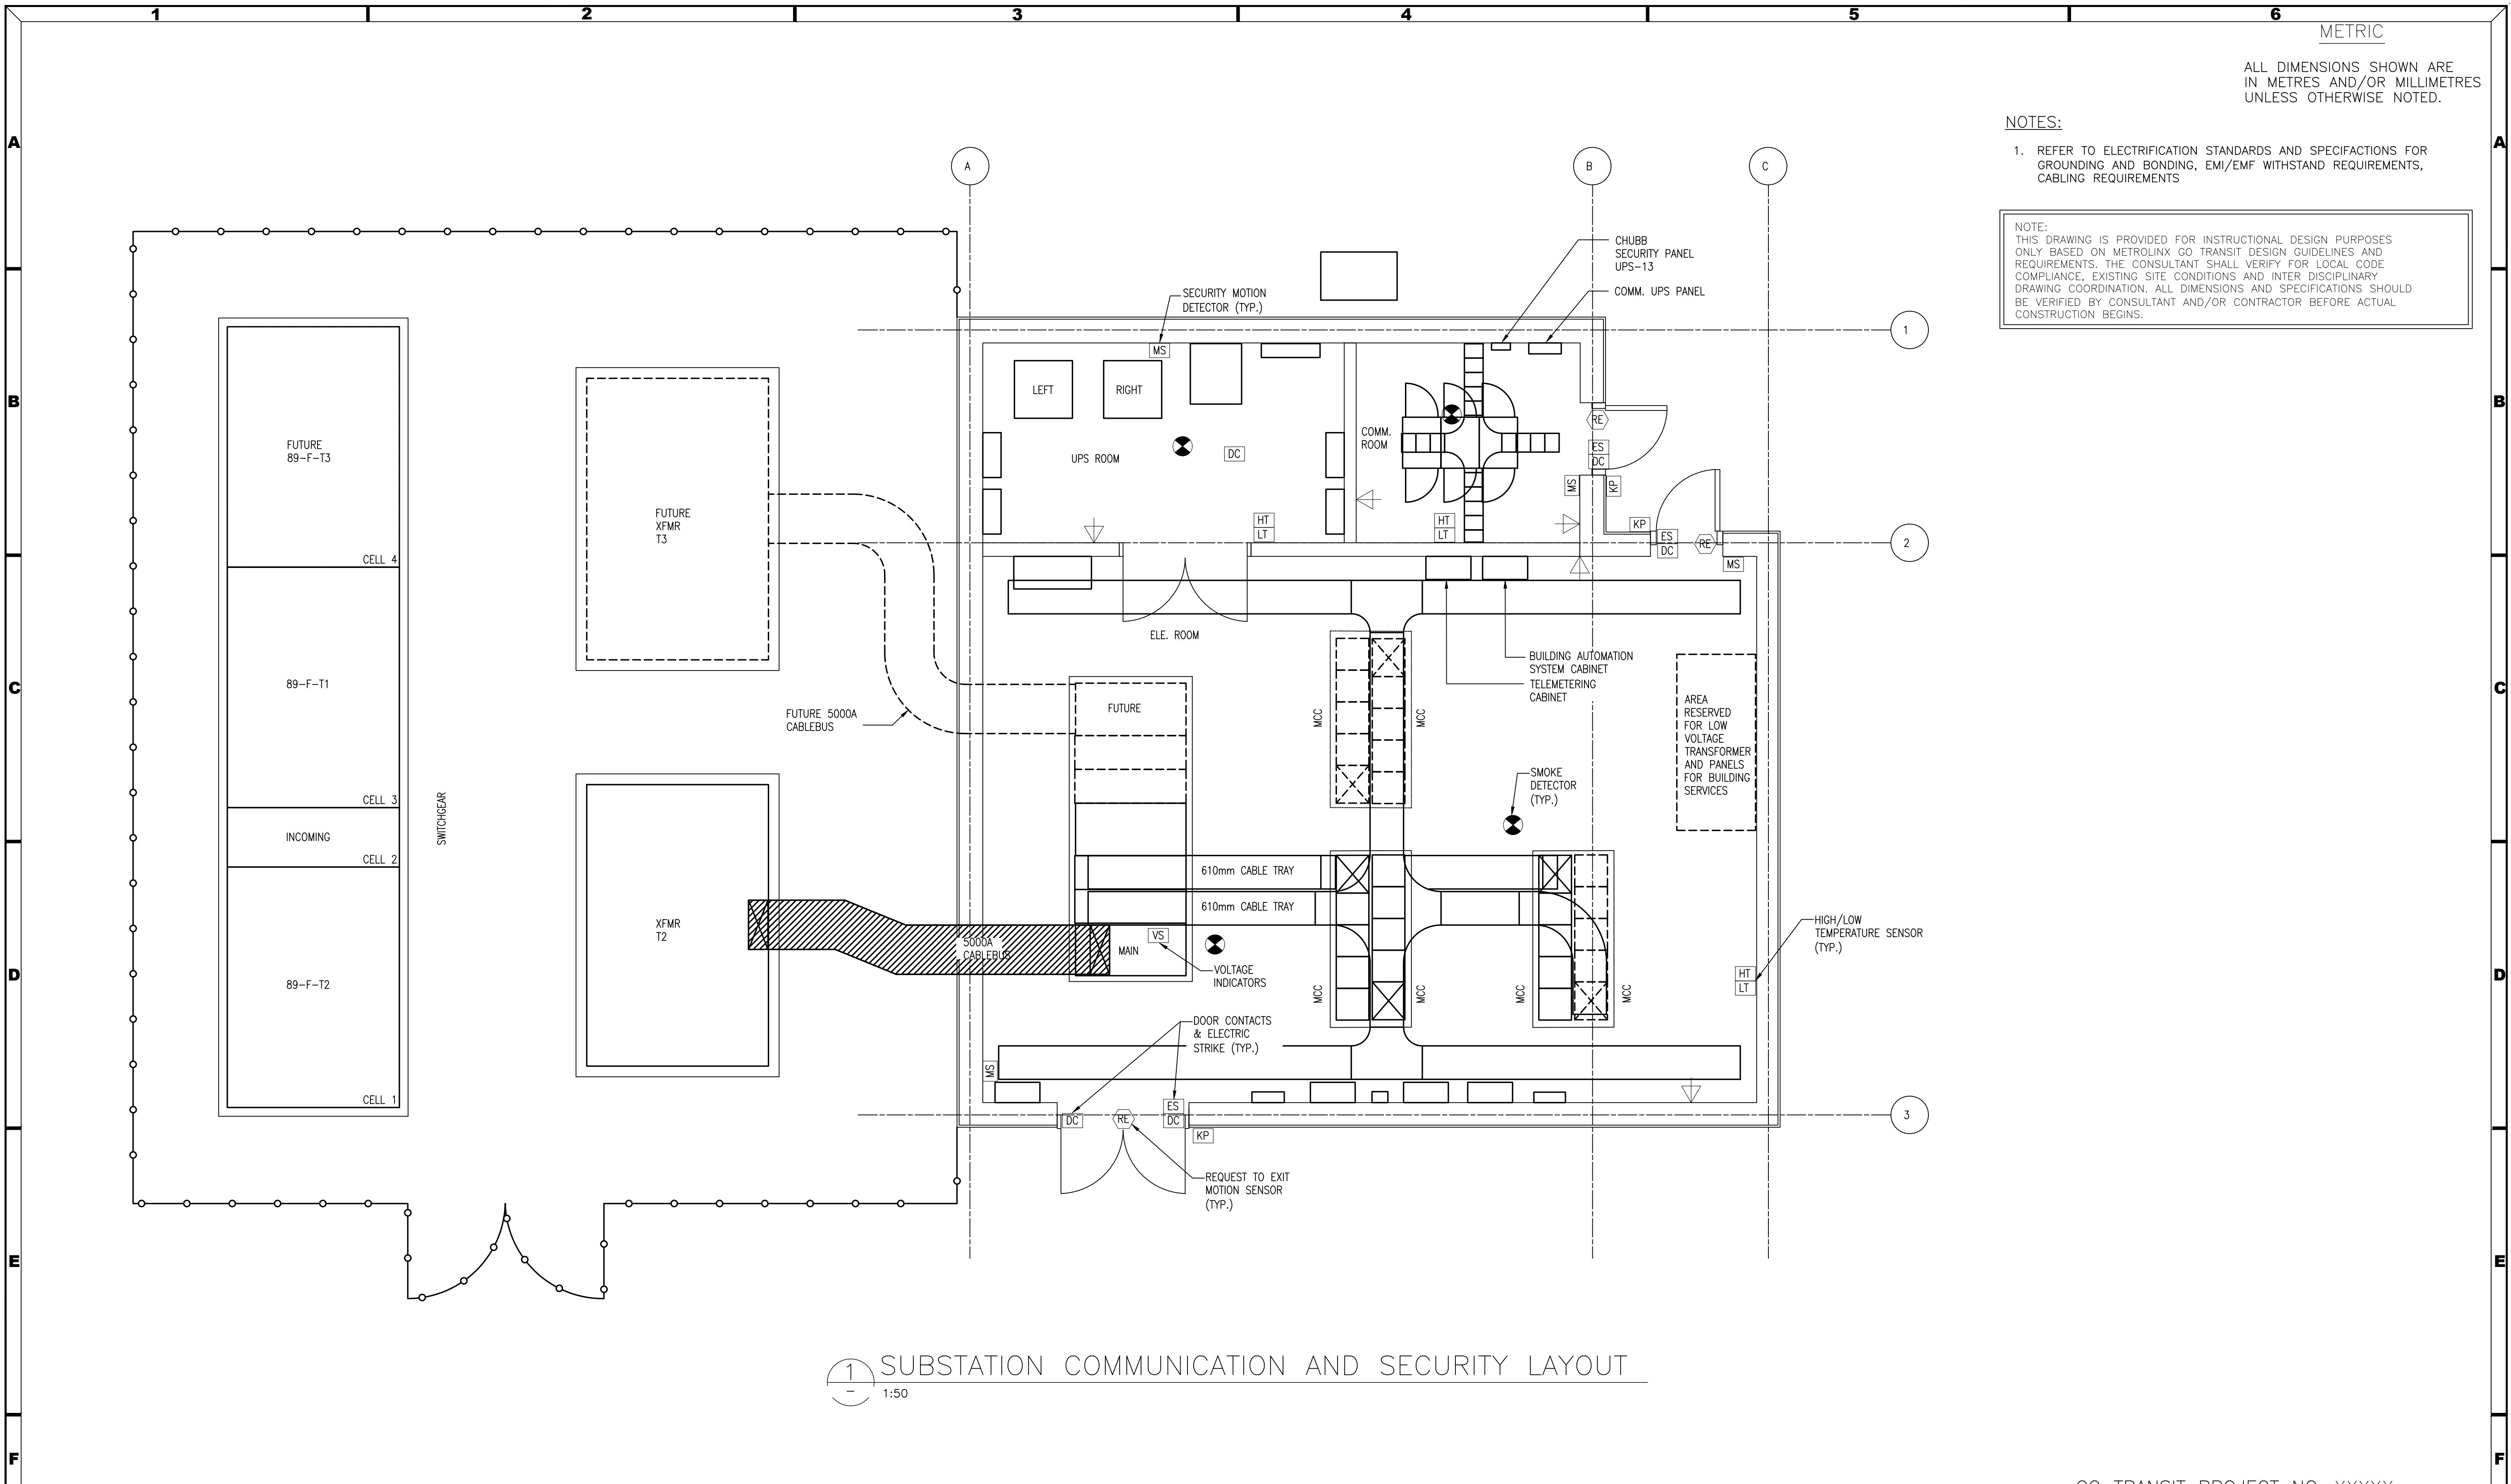

1 SUBSTATION COMMUNICATION AND SECURITY LAYOUT
1:50

AutoCAD drawing: WSP-045.dwg Aug 15/18 12:30pm

GO TRANSIT PROJECT NO. XXXXX

REFERENCE DRAWINGS		ISSUE		REVISIONS	
MAR/2008	WSP-015				
DWG. NO.	TITLE	REV.	DATE	ISSUED FOR	REV. DATE

DRAWN BY:	DESIGNED BY:
CHECKED BY:	APPROVED BY:
SCALE: 1:50 FULL SIZE ONLY	



XXXXXX WAYSIDE POWER SUBSTATION BUILDING COMMUNICATION AND SECURITY LAYOUT			
CONTRACT NO. XXXXXXXXXXXX	DWG. NO. WSP-045	REV. 0	SHEET XX